

Addendum D3

re: Centerville-Abington Community Schools Centerville-Abington Transportation Building 473003.00

issue date: March 25, 2022

This Addendum forms a part of the Contract Documents for the above-referenced project and is issued in accordance with the Instructions to Bidders. Acknowledge receipt of this addendum by inserting its number in the space provided in the bid form.

ITEM	LOCATION	DESCRIPTION
A3.01	SPECIFICATIONS Table of Contents (Reissued)	CHANGE: Issued as part of Addendum D3 is the REVISED Table of Contents that shall be included as an integral part of the project construction documents.
A3.02	DRAWING Sheet A4.0	CHANGE: CHANGE door thickness for Door 100 from 2 ½" to 1 ¾". Drawing not reissued.
CIVIL:		
C3.1	DRAWING C4.0 Site Utility Plan (Drawing Reissued)	ADD: Added Utility Tag #16 to the plan to reference the Oil Interceptor detail. See reissued sheet C4.0.
C3.2	DRAWING C7.1 Site Detail Sheet (Drawing Reissued)	ADD: Added Detail #9 – Oil Interceptor detail and Detail #10 – Inlet Type I detail to the project.



Addendum D3

Centerville-Abington Transportation Building March 25, 2022 Page 2

ITEM

LOCATION

DESCRIPTION

Submitted by:

The Moake Park Group, Inc.


Jeff E. Schroeder Project Architect

attachments: Revised Table of Contents

Drawing C4.0 Drawing C7.1

copies: All Plan Holders

473003/670

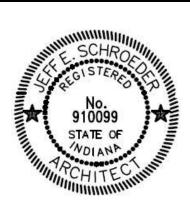

1	Project Manual
2	REVISED TABLE OF CONTENTS
3 4	REVISED TABLE OF CONTENTS
5	
6	VOLUME 1 of 2
7	
8	CERTIFICATION PAGE
9	
10	TABLE OF CONTENTS
11	
12	BIDDING REQUIREMENTS AND FORMS
13	
14	Notice to Bidders
15	Instructions to Bidders (AIA Document A701)
16	Bid Bond (AIA Document A310)
17	Form 96, Contractor's Bid for Public Works
18	Supplementary Bid Form
19	Contractor's Statement of Equal Employment Opportunity
20	Contractor's Qualification Statement (AIA Document A305)
21	Exhibit A – General Information (AIA Document A305)
22	Exhibit B – Financial & Performance Information (AIA Document A305)
23	Exhibit C – Project Specific Information (AIA Document A305
24	Exhibit D – Contractor's Past Project Experience (AIA Document A305)
25	Exhibit E – Contractor's Past Project Experience, Continued (AIA Document A305
26	Proposal Request (AIA Document G709)
27	Construction Change Directive (AIA Document G714) Change Order (AIA Document G701)
28 29	Architect's Supplemental Instructions (AIA Document G710)
30	Certificate of Substantial Completion (AIA Document G704)
31	Application and Certificate for Payment (AIA Document G702)
32	Continuation Sheet (AIA Document G703)
33	Standard Form of Agreement Between Owner and Contractor where the basis of payment is a
34	Stipulated Sum (AIA Document A101-2017)
35	Insurance and Bonds Exhibit A – (AIA Document A101-2017)
36	
37	
38	GENERAL CONDITIONS
39	
40	General Conditions of the Contract for Construction (AIA Document A201)
41	Supplementary Conditions
42	Performance Bond (AIA Document A312)
43	Payment Bond (AIA Document A312)
44	
45	
46	


1	SPECIFICATIO	NS
2		
3	DIVISION 01 -	- GENERAL REQUIREMENTS
4	011000	C
5	011000	Summary
6	012100	Allowances
7	012300	Alternates
8	012500	Substitution Procedures
9	012600	Contract Modification Procedures
10	012900	Payment Procedures
11	013100	Project Management and Coordination
12	013200	Construction Progress Documentation
13	013300	Submittal Procedures
14	014500	Quality Control
15	015000	Temporary Facilities and Controls
16	016000	Product Requirements
17	017300	Execution
18	017329	Cutting and Patching
19	017400 017700	Cleaning and Waste Management Closeout Procedures
20	017700	Closeout Frocedures Closeout Submittals
21	017800	Closeout Submittals
22	DIVISION 02	- EXISTING CONDITIONS
23 24	DIVISION 02	- EXISTING CONDITIONS
24 25	021111	Soils Report (Issued Via Addendum D1)
26	021111	sons report (issued via riaderidam 21)
 27	DIVISION 03 -	- CONCRETE
28		
29	033000	Cast-in-Place Concrete
30		
31	DIVISION 04	- MASONRY
32		
33	042000	Unit Masonry
34		
35	DIVISION 05 -	- METALS
36		
37	051200	Structural Steel Framing
38	053100	Steel Decking
39	054000	Cold Formed Metal Framing
40	055000	Metal Fabrications
41	055100	Metal Stairs
42	055213	Pipe and Tube Railings
43		
44	DIVISION 06 -	- WOOD, PLASTICS, AND COMPOSITES
45		_
46	061053	Miscellaneous Rough Carpentry

1	061600	Sheathing
2		
3	DIVISION 07	– THERMAL AND MOISTURE PROTECTION
4		
5	071900	Water Repellents
6	072100	Thermal Insulation
7	076200	Sheet Metal Flashing and Trim
8	077253	Snow Guards (Issued Via Addendum D1)
9	079200	Joint Sealants
10		
11	DIVISION 08	– OPENINGS
12		
13	081113	Hollow Metal Doors and Frames
14	081416	Flush Wood Doors
15	083613	Sectional Doors
16	084113	Aluminum Framed Entrances & Storefronts
17	087100	Door Hardware (Issued via Addendum D1)
18	088000	Glazing
19		
20	DIVISION 09	– FINISHES
21		
22	092216	Non-Structural Metal Framing
23	095113	Acoustical Panel Ceilings
24	096513	Resilient Base and Accessories
25	096519	Resilient Tile Flooring
26	099100	Painting
27		
28	DIVISION 10	– SPECIALTIES
29		
30	102800	Toilet, Bath, and Laundry Accessories
31	104413	Fire Protection Cabinets
32	104416	Fire Extinguishers
33		
34	DIVISION 12	– FURNISHINGS
35		
36	123200	Manufactured Wood Casework
37		
38	DIVISION 13	– SPECIAL CONSTRUCTION
39		
40	133419	Metal Building Systems (Issued via Addendum D1)
41		

1	VOLUME 2 of 2	
2	CERTIFICATION	24.05
3	CERTIFICATION	PAGE
4	TABLE OF CONT	TENTS
5	TABLE OF CONT	EINIS
6	DIVISION 21 – I	FIRE SUPPRESSION
7	DIVISION 21 - I	-INE SUFFRESSION
8 9	210500	Common Work Results for Fire Suppression
10	210500	Sleeves and Sleeve Seals for Fire-Suppression Piping
11	210517	Escutcheons for Fire-Suppression Piping
12	210513	General-Duty Valves for Fire Suppression Piping
13	210529	Hangers and Supports for Fire Suppression Piping and Equipment
14	210553	Identification for Fire-Suppression Piping and Equipment
	211119	Fire Department Connections
15		•
16	211313	Wet-Pipe Sprinkler Systems
17	211316	Dry-Pipe Sprinkler Systems
18	DIVISION 22 – F	DILIMPING
19	DIVISION 22 - I	LUMBING
20	220500	Common Work Docults for Dlumbing
21	220500	Common Work Results for Plumbing
22	220519	Meters and Gages for Plumbing Piping
23	220523.12	Ball Valves for Plumbing Piping
24	220523.13	Butterfly Valves for Plumbing Piping
25	220523.14	Check Valves for Plumbing Piping
26	220523.15	Gate Valves for Plumbing Piping
27	220529	Hangers and Supports for Plumbing Piping And Equipment
28	220553	Identification for Plumbing Piping and Equipment
29	220719	Plumbing Piping Insulation
30	221116	Domestic Water Piping
31	221119	Domestic Water Piping Specialties
32	221316	Sanitary Waste and Vent Piping
33	221319	Sanitary Waste Piping Specialties
34	221319.13	Sanitary Drains
35	223300	Electric, Domestic-Water Heaters
36	224000	Plumbing Fixtures
37	224213.13	Commercial Water Closets
38	224216.13	Commercial Lavatories
39	224500	Emergency Plumbing Fixtures
40	224716	Pressure Water Coolers
41		
42	DIVISION 23 - H	HEATING, VENTILATING AND AIR CONDITIONING
43		
44	230500	Common Work Results for HVAC
45	230513	Common Motor Requirements for HVAC Equipment
46	230529	Hangers and Supports for HVAC Piping and Equipment

1	230553	Identification for HVAC Piping and Equipment
2	230593	Testing, Adjusting, and Balancing for HVAC
3	230713	Duct Insulation
4	230719	HVAC Piping Insulation
5	231123	Facility Natural-Gas Piping
6	232300	Refrigerant Piping
7	233113	Metal Ducts
8	233300	Air Duct Accessories
9	233346	Flexible Ducts
10	233411	Fixed Louvers
11	233423	HVAC Power Ventilators
12	233439	High-Volume, Low Speed Fans
13	233713	Diffusers, Registers, and Grilles
14	235100	Breechings, Chimneys, and Stacks
15	235400	Furnaces
16	235523.13	Low-Intensity, Gas-Fired, Radiant Heaters
17	235533.16	Gas-Fired Unit Heaters
18	236313	Air-Cooled Refrigerant Condensers
19	238126	Split-System Air-Conditioner
20	238239.19	Wall and Ceiling Hung Heaters
21		
22	DIVISION 26 -	ELECTRICAL
23		
24	260500	Common Work Results for Electrical
25	260519	Low-Voltage Electrical Power Conductors and Cables
26	260526	Grounding and Bonding for Electrical Systems
27	260533	Raceway and Boxes for Electrical Systems
28	260553	Identification for Electrical Systems
29	260923	Lighting Control Devices
30	262416	Panelboards
31	262726	Wiring Devices
32	262813	Fuses
33	262816	Enclosed Switches and Circuit Breakers
34	265100	Interior Lighting
35	265600	Exterior Lighting
36		
37	DIVISION 28 -	ELECTRONIC SAFETY AND SECURITY
38		
39	283111	Fire Alarm System
40		
41	DIVISION 31 -	EARTHWORK
42		
42 43	310000	Control of Site Work
		Control of Site Work Site Demolition
43	310000	
43 44	310000 311000	Site Demolition

1	DIVISION 3 2	2 – EXTERIOR IMPROVEMENTS
2		
3	321216	Bituminous Concrete Pavement
4	321313	Portland Cement Concrete Pavement
5	323113	Chain Link Fence and Gates
6	329200	Lawns and Grasses
7		
8	DIVISION 3	3 – UTILITIES
9		
10	330500	Site Utility Piping
11	331116	Site Water Distribution
12	333114	Sanitary Sewer System
13	334100	Storm Drainage System
14		
15	DIVISION 4:	1 – MATERIAL PROCESSING AND HANDLING EQUIPMENT
16		
17	412200	Cranes and Hoists (Issued Via AddendumD1)
18		
19		
20		
21	END OF TAE	BLE OF CONTENTS

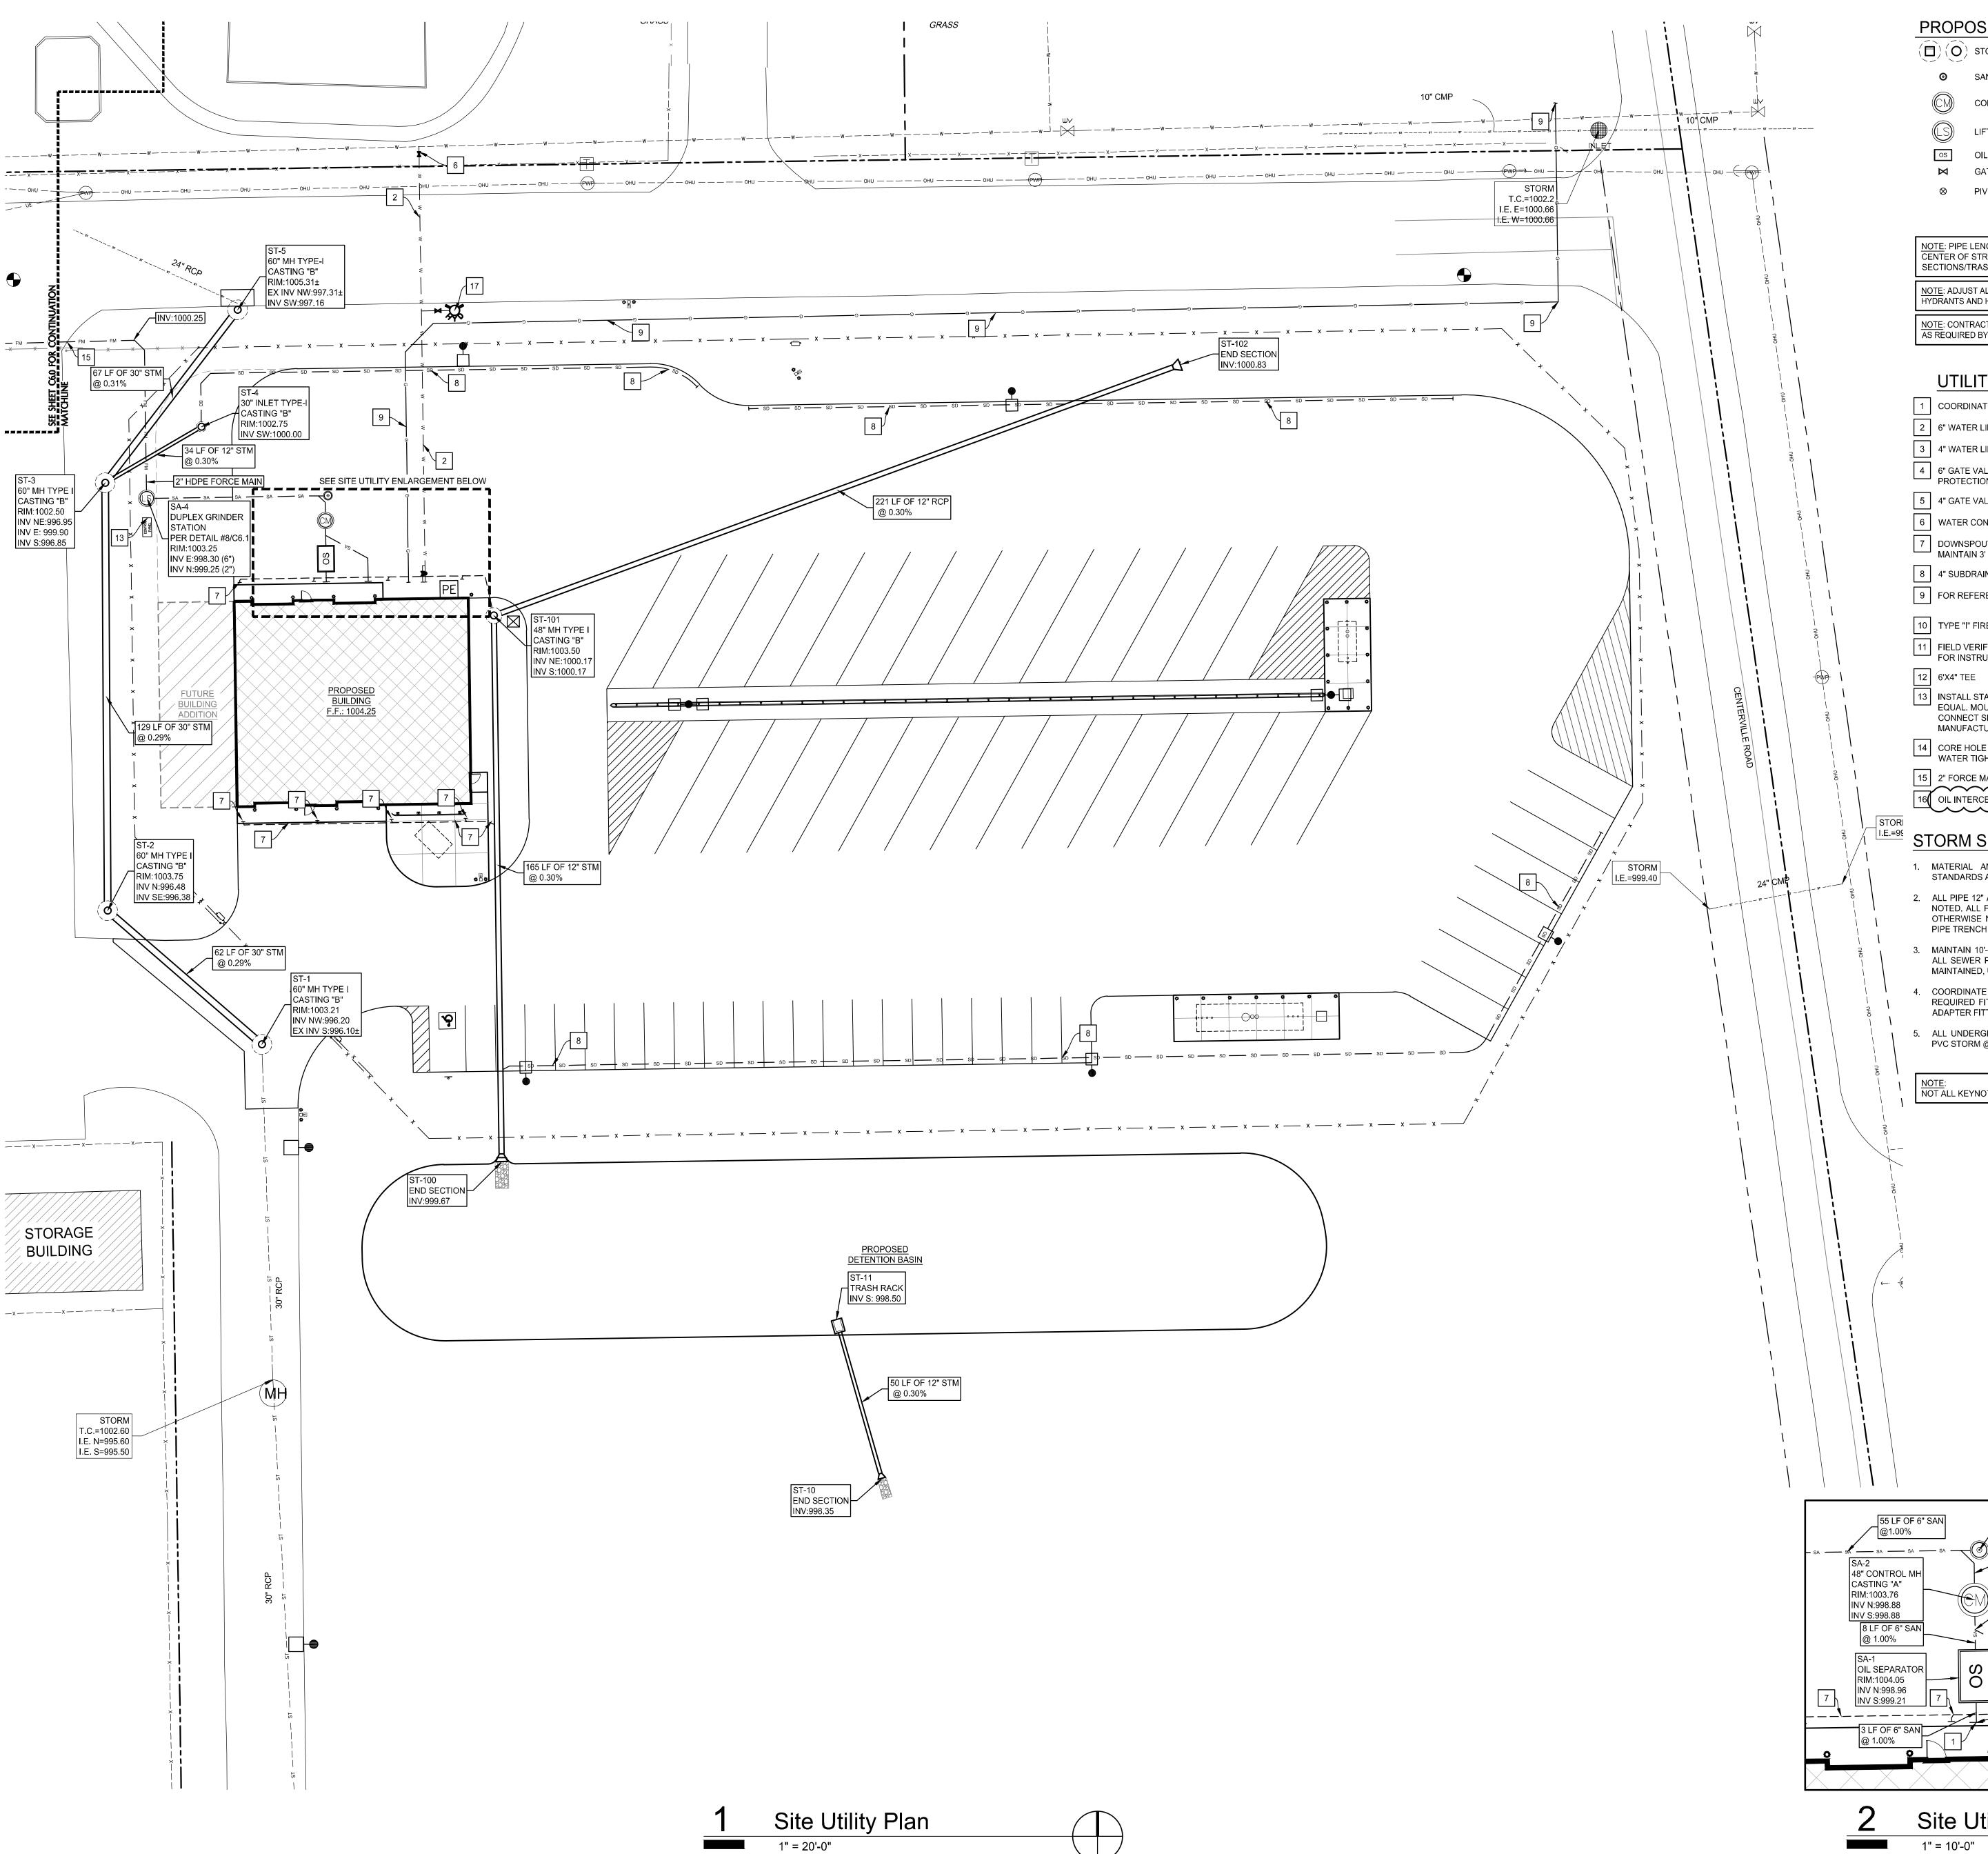

PROPOSED LEGEND:

() (O) STORM INLET / MANHOLE STORM SEWER SANITARY CLEANOUT — sa — sa — sa — sa — **SANITARY SEWER** —— GAS —— GAS LINE CONTROL MANHOLE LIFT STATION — w — w — w — WATER LINE OIL SEPARATOR — FM —— FM —— FM — FORCE MAIN **GATE VALVE** ----- GAS ----- GAS LINE — sd — sd — sd — SUBDRAIN

NOTE: PIPE LENGTHS ARE MEASURED TO THE CENTER OF STRUCTURES AND THE END OF END SECTIONS/TRASH RACKS UNLESS OTHERWISE NOTED NOTE: ADJUST ALL EXISTING MANHOLES, VALVES, IYDRANTS AND HANDHOLES TO PROPOSED GRADES. NOTE: CONTRACTOR SHALL PROVIDE TRAFFIC CONTROL AS REQUIRED BY STATE AND LOCAL AUTHORITIES.

UTILITY NOTES:

1 COORDINATE CONNECTION WITH THE BUILDING DRAWINGS.

2 6" WATER LINE

3 4" WATER LINE

PROTECTION FOR CONNECTION TO CONTROL SYSTEM.

5 4" GATE VALVE AND VALVE BOX

6 WATER CONNECTION, 6" X 6" TAPPING SLEEVE, VALVE & VALVE BOX.

DOWNSPOUT DRAIN @ MINIMUM 1.00%. CONNECT TO DOWNSPOUTS AS REQUIRED. MAINTAIN 3' MINIMUM COVER. SEE BUILDING PLANS.

4 6" GATE VALVE, VALVE BOX, AND POST INDICATOR WITH STATUS SWITCH. SEE FIRE

8 4" SUBDRAIN @ MIN. 2.0% PER DETAIL #7/C7.1.

9 FOR REFERENCE ONLY: GAS (BY UTILITY COMPANY)

10 TYPE "I" FIRE HYDRANT ASSEMBLY PER DETAIL #3/C7.1

11 FIELD VERIFY DEPTH AND LOCATION OF EXISTING UTILITY. NOTIFY ENGINEER AND WAIT FOR INSTRUCTION IF CONFLICTS WITH PROPOSED CONSTRUCTION.

12 6'X4" TEE

EQUAL. MOUNT CONTROL PANEL ON MOUNTING SYSTEM PER DETAIL ON ELECTRICAL PLAN. CONNECT SPECIFIED CONTROL PANEL TO DUPLEX GRINDER STATION PER MANUFACTURER'S RECOMMENDATIONS. COORDINATE WITH SITE ELECTRIC PLANS.

13 INSTALL STAHLIN ENCLOSURES CONTROL PANEL MODEL #: "RJ1816HPL" OR APPROVED

14 CORE HOLE IN EXISTING MANHOLE FOR PROPOSED SANITARY CONNECTION. PROVIDE WATER TIGHT CONNECTION.

2" FORCE MAIN TO BE DIRECTIONALLY DRILLED BELOW ASPHALT.

16 OIL INTERCEPTOR PER DETAIL #9/C7.1.

STORM SEWER NOTES:

1. MATERIAL AND WORKMANSHIP SHALL COMPLY WITH THE TOWN OF CENTERVILLE STANDARDS AND SPECIFICATIONS.

2. ALL PIPE 12" AND SMALLER SHALL BE SDR 35 PVC, OR ADS N-12 HDPE UNLESS OTHERWISE NOTED. ALL PIPE LARGER THAN 12" SHALL BE ADS N-12 HDPE OR C76 CL-111 RCP UNLESS OTHERWISE NOTED. ALL PIPE SHALL BE INSTALLED ACCORDING TO SPECIFICATIONS AND PIPE TRENCH DETAIL #1/C7.1.

3. MAINTAIN 10'-0" MINIMUM HORIZONTAL AND 18" MINIMUM VERTICAL SEPARATION BETWEEN ALL SEWER PIPING AND POTABLE WATER PIPING. WHEN MINIMUM TOLERANCES CAN'T BE MAINTAINED, USE WATERWORKS GRADE PIPE AND FITTINGS OF MATERIAL SELECTED.

4. COORDINATE TAP LOCATIONS FOR DOWNSPOUTS WITH BUILDING DRAWINGS. ASSURE ALL REQUIRED FITTINGS ARE INSTALLED ON THE MAIN LINE PRIOR TO BACKFILLING. INCLUDE ADAPTER FITTING FOR DOWNSPOUTS.

5. ALL UNDERGROUND PIPING FOR DOWNSPOUT COLLECTION SYSTEM SHALL BE 6" SDR 35 PVC STORM @ 1.00% MIN. SLOPE UNLESS NOTED OTHERWISE.

NOT ALL KEYNOTES ARE USED ON THIS SHEET.

6" CLEANOUT

Site Utility Enlargement

22 LF OF 6" SAN @ 1.00%

RIM:1003.70 INV N:998.85

@ 1.00%




7223 Engle Rd. Suite 200, Fort Wayne, IN 46804 260-424-6516




www.moakepark.com

11020 Diebold Road, Fort Wayne, IN 46845 Ph: (260) 490-1025 Fax: (260) 490-1026 www.eri.consulting

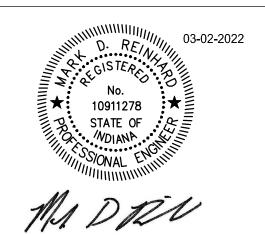

A PROJECT FOR:



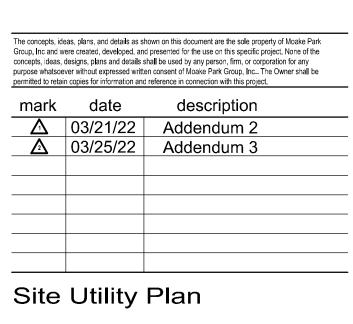


date: March 2, 2022 project: 473003 coordinator: DLR C4.0 drawn: CMF checked: MDR



ENGINEERING RESOURCES, INC 11020 Diebold Road, Fort Wayne, IN 46845 Ph: (260) 490-1025 Fax: (260) 490-1026

www.eri.consulting

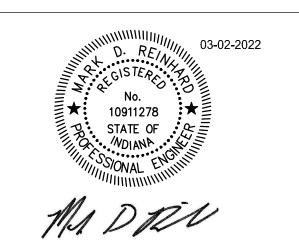

CHOO

FIRE HYDRANT SHACKLED TO THIS ARRANGEMENT - 6" X 24" MIN. NIPPLE CAN BE USED ON ALL SIZES OF MAINS 6' VALVE w/BOX SHACKLED TO TEE

— 6" X 13" MIN NIPPLE

- 6"x(MAIN)"x(MAIN)" TEE

DESCRIPTION

"SANITARY

SEWER"

LETTERING

LOGO

*WHEN USED WITH STORM INLET, CONTRACTOR TO VERIFY IF A SPECIAL ORDER CASTING

CASTING SCHEDULE

PLAN VIEW

SECTION VIEW

HYDRANT TYPE "I"

SCALE: N.T.S.

CATALOG NUMBER

NEENAH EAST JORDAN

LID & FRAME: | LID: 1020AHDGS

FRAME: 1772 | FRAME: 1022

NOTES: 1. CASTINGS SPECIFIED, OR APPROVED EQUAL

2. ALL BEARING SURFACES TO BE MACHINED.

IS NEEDED TO PROVIDE SUFFICIENT SUPPORT.

SCALE: NONE

3. COMPLY WITH ASTM A48-83 CLASS #35.

FRAME: 1022Z1

LID: 2502 | LID: 1022-M1 | OPEN W/ FISH

1772

G TYPE

MANHOLE TOP IN

ALIGNMENT WITH STEPS

4" CONCRETE

ADJUSTMENT RING.

4

SEE PLAN

/2'-0"

REINFORCING STEEL PER

ASTM SPEC. C-478

MANHOLE TOP IN

PROVIDE 1 RING MAX.

₹ 3000 PSI

WALL THICKNESS

"A" MH DIA. "B"

4" CONCRETE

RING MAX.

3000 PSI CONCRETE


REINFORCING STEEL PER

ASTM SPEC. C-478

SCALE: 3/8" = 1'-0"

ADJUSTMENT


 $^{'}$ RING. PROVIDE $^{\prime}$

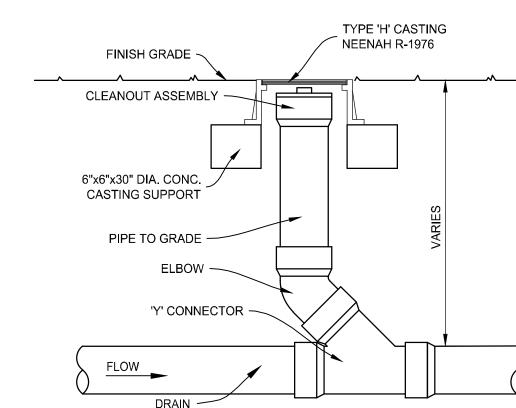

PVC CLEANOUT SCALE: N.T.S.


BEDDING SPECIFICATIONS

1. FOR ROCK OR OTHER NON-COMPRESSIBLE MATERIAL, THE TRENCH SHALL BE OVER EXCAVATED A MINIMUM OF 6" AND REFILLED WITH BEDDING MATERIAL.

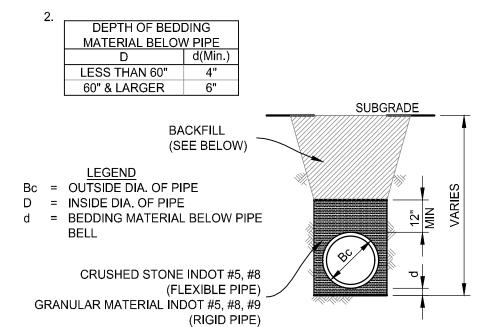

BACKFILL SPECIFICATIONS BACKFILL WITHIN PUBLIC R.O.W., UNDER PAVED AREAS, AND WITHIN THE INFLUENCE OF BUILDING STRUCTURES SHALL BE INDOT #53/#73. INFLUENCE ZONE SHALL EXTEND AT A 1:1 SLOPE FROM ABOVE ITEM. COMPACTION SHALL MEET OR EXCEED 95% OF MAXIMUM DRY UNIT WEIGHT ACCORDING TO ASTM D 1557.

2. BACKFILL WITHIN LAWN AREAS AND OUT OF THE INFLUENCE OF: BUILDING STRUCTURES, PAVED AREAS, AND PUBLIC R.O.W., SHALL BE STANDARD BACKFILL. STANDARD BACKFILL SHALL BE FREE OF: ROCK AND GRAVEL LARGER THAN 3" IN ANY DIMENSION, DEBRIS, WASTE, FROZEN MATERIALS, VEGETATION, AND OTHER DELETERIOUS MATERIAL ACCORDING TO ASTM D 2487. COMPACTION SHALL MEET OR EXCEED 90% OF MAXIMUM DRY UNIT WEIGHT ACCORDING TO ASTM D 1557.

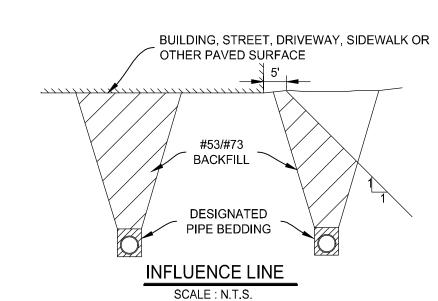

PIPE TRENCH DETAIL

he concepts, ideas, plans, and details as shown on this document are the sole property of Moake Parl Group, Inc and were created, developed, and presented for the use on this specific project. None of the concepts, ideas, designs, plans and details shall be used by any person, firm, or corporation for any purpose whatsoever without expressed written consent of Moake Park Group, Inc.. The Owner shall be mark date description 03/21/22 Addendum 2

date: March 2, 2022 project: 473003 coordinator: DLR

Site Details

drawn: CMF

checked: MDR

DUPLEX GRINDER STATION

SCALE: NONE

GRINDER STATION NOTES:

FOR INFORMATION.

ISOLATION VALVES.

CONNECTIONS, AND

BE LOCKABLE.

TO CONSTRUCTION.

DISCONNECT SIZED

ENCLOSURE.

CONSTRUCTION.

FOLLOWS:

SCALE: NONE

A PROJECT FOR:

